



TRAFFIC IMPACT AND PARKING ASSESSMENT

**RESIDENTIAL DEVELOPMENT AT
71-73 VICLIFFE AVE,
CAMPSIE NSW 2194**

**PREPARED FOR
SIMPSON BUILDING GROUP**

**IN-COORDINATION WITH
STANTON DAHL ARCHITECTS**

DATE: 23RD NOVEMBER 2022

OUR REFERENCE: 220215

BY: ANTHONY OSTE

Author	Anthony Oste	
Approved by	Alistair McKerron	
REVISION	DATE	DESCRIPTION
A	23 rd November 2022	For Approval
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1 INTRODUCTION

1.1 GENERAL

Greenview Consulting has been engaged by the client to undertake a review of traffic and parking at the subject site. This report must be read in conjunction with the other Development Application documents and other relevant information, including:

- State Environment Planning Policy (Housing) 2021
- Stanton Dahl design drawings (November 2022)
- RTA (RMS) Guide to Traffic Generating Developments (October 2002)

This purpose of this report is to:

- Describe the site and the proposed development scheme;
- Describe the road network, the prevailing traffic conditions and the public transport options serving the site;
- Assess the social and demographic impacts of the proposed development;
- Assess the adequacy of the proposed parking provision;
- Assess the potential traffic implications and impacts to pedestrians;
- Assess the suitability of the proposed vehicles access, internal circulation and servicing arrangements.

2 EXISTING CONDITIONS

2.1 SITE DESCRIPTION

The subject site is located on the south-western side of Vicliffe Ave, refer **Figure 2.1**. The site is currently occupied by two single-storey residential dwellings.



Figure 2.1 Site Location

The site includes the following lots: Lot 20 DP 35130 and Lot 18 DP 35848. The total area occupied by the subject site is approximately 1200m².



Figure 2.2 Site Frontage from Vicliffe Ave, looking west
Image courtesy of Google Maps (Street View, capture date February 2021)

2.2 EXISTING ROAD CONDITIONS

The Roads & Maritime Services (RMS, formerly RTA) broadly classifies all roads into three administrative classes: state, regional and local. A detailed description of each administrative class is provided in “NSW Road Management Arrangements” (December 2008), however in general:

State Roads are the major arterial links throughout NSW and within major urban areas. They are the principal traffic carrying and linking routes for the movement of people and goods within the Sydney, Newcastle, Wollongong and Central Coast urban areas and which connect between these urban centres, the major regional towns, the major regions of the State and the major connections interstate.

Regional Roads are routes of secondary importance between State Roads and Local Roads which together with the State Roads, provide the main connections to and between smaller towns and districts and perform a sub arterial function in major urban areas.

Local Roads comprise the remaining Council controlled roads which provide for local circulation and access.

Vicliffe Ave is a local road with 2 lanes of traffic in each direction and no marked divider. Parking is generally allowed along most portions of the street. The posted local speed limit is 50 km/hr. The road narrows directly outside the site to allow parallel parking along one side of the road only.

Bexley Rd is a state road with two lanes for each direction of traffic, divided by a single broken line. In the site vicinity, on either side of the road, a clearway operates between the times of 6-10am and 3-7pm Monday to Friday. Outside of these times parking is generally allowed on the western side of the road, but prohibited along the eastern side. The posted speed limit is 60 km/hr.



Figure 2.3 Road Classification

2.3 EXISTING ROAD FEATURES

The existing road features which apply to the road network in the vicinity of the site are illustrated in **Figure 2.5**. These include:

- Bus zones along Bexley Rd
- Parking is generally allowed in the site vicinity in the local roads, but restricted along Bexley Rd;
- The default local speed limit is 50 km/hr;

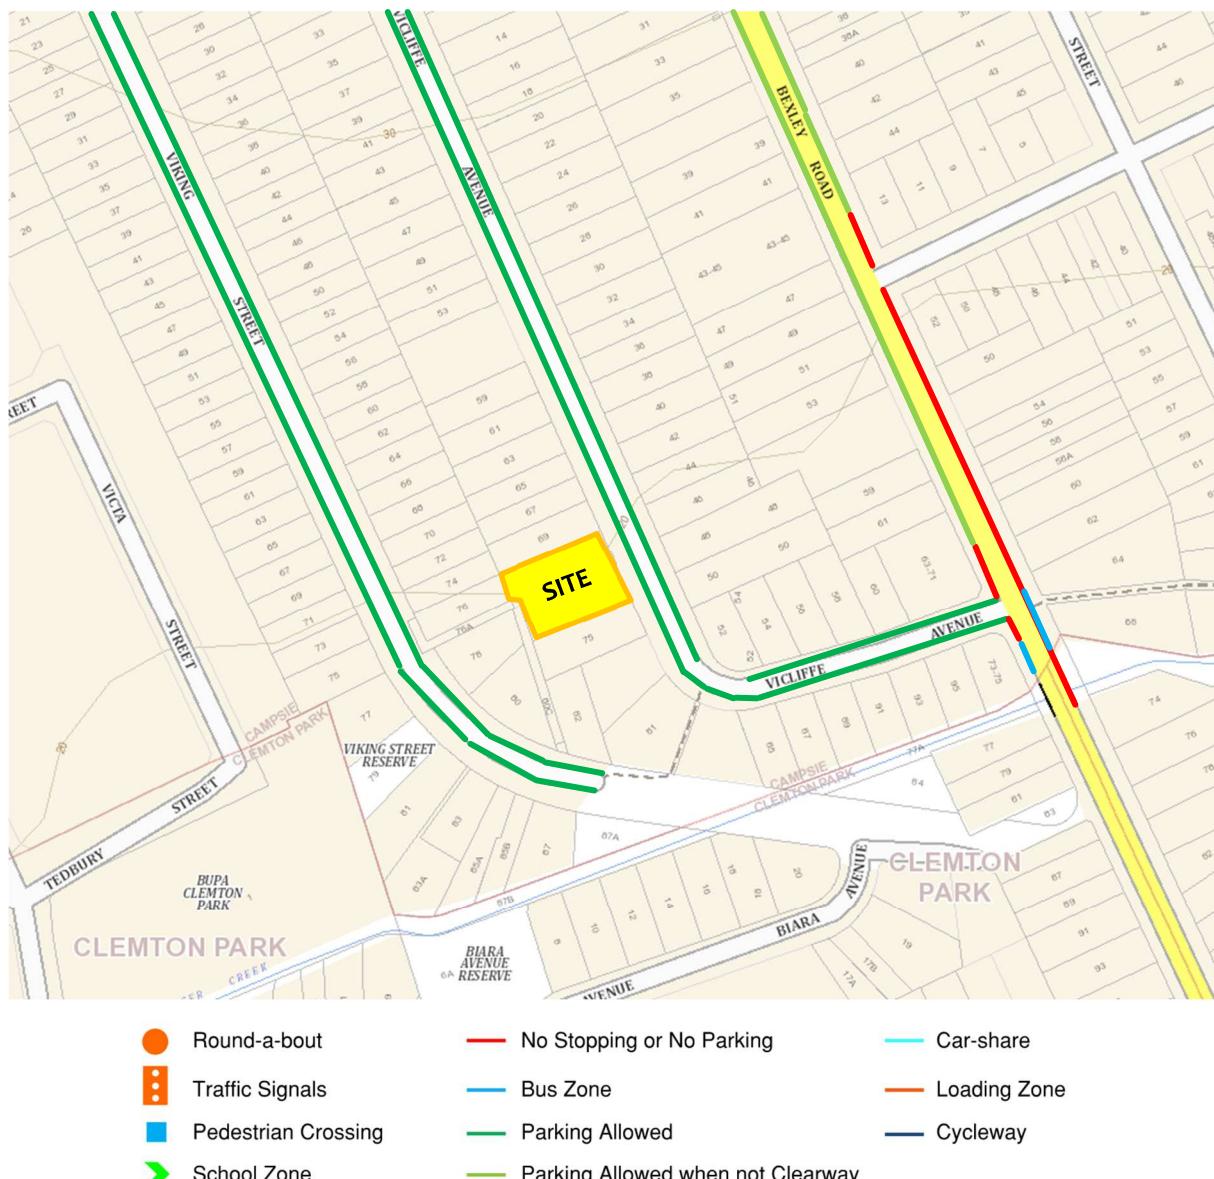


Figure 2.3 Existing Road Features

2.4 TRAFFIC DATA

As far as we are aware, there are no readily available traffic counts in the local vicinity.

2.5 PUBLIC TRANSPORT

The nearest train station to the subject site is Campsie Station (1.4km walking distance to the north) on the T3 Liverpool/Lidcombe Line; this station provides direct access for commuters to the Sydney CBD. The estimated walking time for a commuter from the site to Campsie station is 18 minutes. Other stations nearby are Canterbury Station (2.1km, 26 mins walking time), Belmore Station (2.3km, 28 mins walking time) and Bexley North Station (2.3km, 29 mins walking time).

There is a bus station on Bexley Rd to the east (210m walking distance) which services routes 410 (Macquarie Park to Hurstville) and 412 (Campsie to City Martin Place via Earlwood & Dulwich Hill).

We therefore conclude that the subject site has satisfactory access to public transport.

2.6 SOCIAL & DEMOGRAPHIC INFORMATION

2021 Census Data (refer www.censusdata.abs.gov.au) was used to construct a community profile of the suburb of Campsie. The most relevant census data categories are reproduced in **Table 2.1**; we have also provided values for NSW to allow general comparisons to be made.

Campsie exhibits more single-car ownership but less car-use than NSW as a whole, and has a significant degree of people who travel to work by public transport. We expect these levels of public transport usage and car-use/ownership will carry across to the residents of the proposed development.

Table 2.1 Demographic Information

Category	Campsie %	NSW %
Employment		
Worked Full-time	42.0	55.2
Worked Part-time	28.7	29.7
Unemployed	8.0	4.9
Travel to Work		
By car (as driver or passenger)	34.3	47.2
By public transport	14.7	4.0
Walked only	2.6	2.5
Number of registered motor vehicles per dwelling		
0	19.1	9.0
1	47.8	37.8
2	22.6	34.1
3+	7.4	17.5

3 PROPOSED DEVELOPMENT

3.1 PROPOSED DEVELOPMENT DESCRIPTION

The development as currently proposed consists of an multi dwelling housing development consisting of 8 2-bed townhouses.

With respect to deliveries to site, it is not expected that any regular deliveries will occur.

3.2 SITE ACCESS & SERVICING

It is currently proposed that the site will be accessed from Vicliffe Ave, refer **Figure 3.1**.

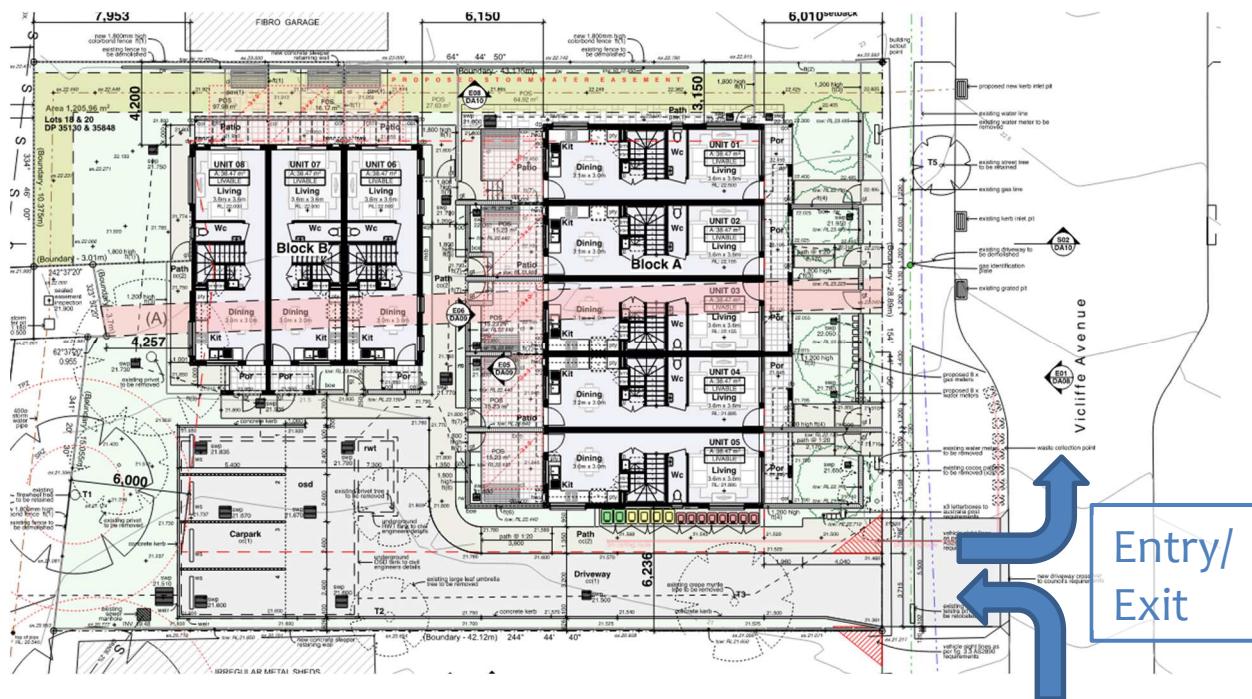


Figure 3.1 Proposed Entry / Exit Point

Swept Paths Analysis

We have undertaken swept-path analysis using Autotrack (refer attached turning plans), this analysis indicates that:

- A B99 and B85 vehicle can pass each other within the 5.5m wide access driveway.
- A B85 vehicle can enter the site in a forwards direction, manouevre into each parking space, and exit the site in a forwards direction.

Garbage Collection

Garbage collection will be via council's typical kerbside collection service. The bins are located on the northern side of the driveway, and will be moved to the kerb for collection.

3.3 ONSITE PARKING PROVISIONS

Parking will be provided in accord with the State Environment Planning Policy (Housing) 2021. Any number greater than the minimum will be compliant with Council controls, as demonstrated following.

- Residential development – Land and Housing Corporation (development in an accessible area):
 - For each dwelling containing 1 bedroom – 0.4 spaces
 - For each dwelling containing 2 bedroom – 0.5 spaces
 - For each dwelling containing 3+ bedroom – 1 space

The calculations are summarised in **Table 3.1** below.

Table 3.1 Car Parking Requirements (Maximum)

Type	Number	Rate	Spaces Required
2-Bedroom Dwellings	8	0.5 sp per dwelling	4
MINIMUM REQUIRED			4

The proposed development incorporates **four (4) spaces** on the ground floor level, thus parking meets the minimum requirement under the SEPP (Housing) 2021.

Accessible Parking

Accessibility requirements for the proposed development are discussed in the access consultant's report, which forms part of the DA submission.

3.4 PEDESTRIAN ISSUES

There is a formal pedestrian footpath along the Vicliffe Ave site frontage, and this will be maintained under proposed conditions. When any work is performed within the frontage area, pedestrian access along the frontage or eastern boundary is to be maintained. Any road frontage works may need to be completed in two stages to ensure a safe path of travel for pedestrians.

4 TRAFFIC GENERATION

4.1 TRAFFIC GENERATION

The RTA *Guide to Traffic Generating Developments*, October 2002, Section 3 - Land Use Generation (Section 3) provides estimated traffic generation rates for various development types, as noted below. The existing site includes 2 residential dwellings. The 'Medium density residential flat building' traffic generation rates have been assessed as the closest match for the nature of the proposed development.

- A. Residential (dwelling houses): 9 daily vehicle trips per dwelling
 0.85 weekday peak-hour trips per dwelling
- B. Residential (medium density flat building – up to 2-bedroom flats): 4-5 daily vehicle trips per dwelling
 0.4-0.5 weekday peak-hour trips per dwelling

Table 4.1 Traffic Generated Under Proposed Conditions

	Weekday Daily vehicle trips	Weekday Peak hour vehicle trips
Existing	<i>2 Dwelling Houses</i> $2*9 = 18 \text{ vt}$	<i>2 Dwelling Houses</i> $2*0.85 = 1.7 \text{ vt}$
Proposed	<i>8 Townhouses</i> $8*5 = 40 \text{ vt}$	<i>8 Townhouses</i> $8*0.5 = 4 \text{ vt}$
Net change	$40-18 = +22 \text{ vt}$	$4-1.7 = +2.3 \text{ vt}$

vt = vehicle trips

The above calculations indicate a slight increase on the existing traffic network, however as such, we believe the development as proposed will not have detrimental traffic impacts in the locale in terms of the traffic efficiency, amenity, safety, and/or road pavement life.

5 CONCLUSIONS

We conclude that:

- We believe that the proposed development will not have a significant impact on the traffic in the local network.
- We believe the development will not have a significant impact on the locale in terms of the traffic efficiency, amenity, safety, and/or road pavement life.
- The proposed development meets the minimum parking requirement under the SEPP (Housing) 2021, outlined in Table 3.1.

Yours faithfully,
For & on behalf of Greenview,



Anthony Oste
Traffic Designer




Alistair McKerron B.E., M.I.E.(Aust), CP Eng,
NPER No. 2220277
Senior Project Engineer




APPENDICES
SWEPT PATH ANALYSIS – GREENVIEW CONSULTING



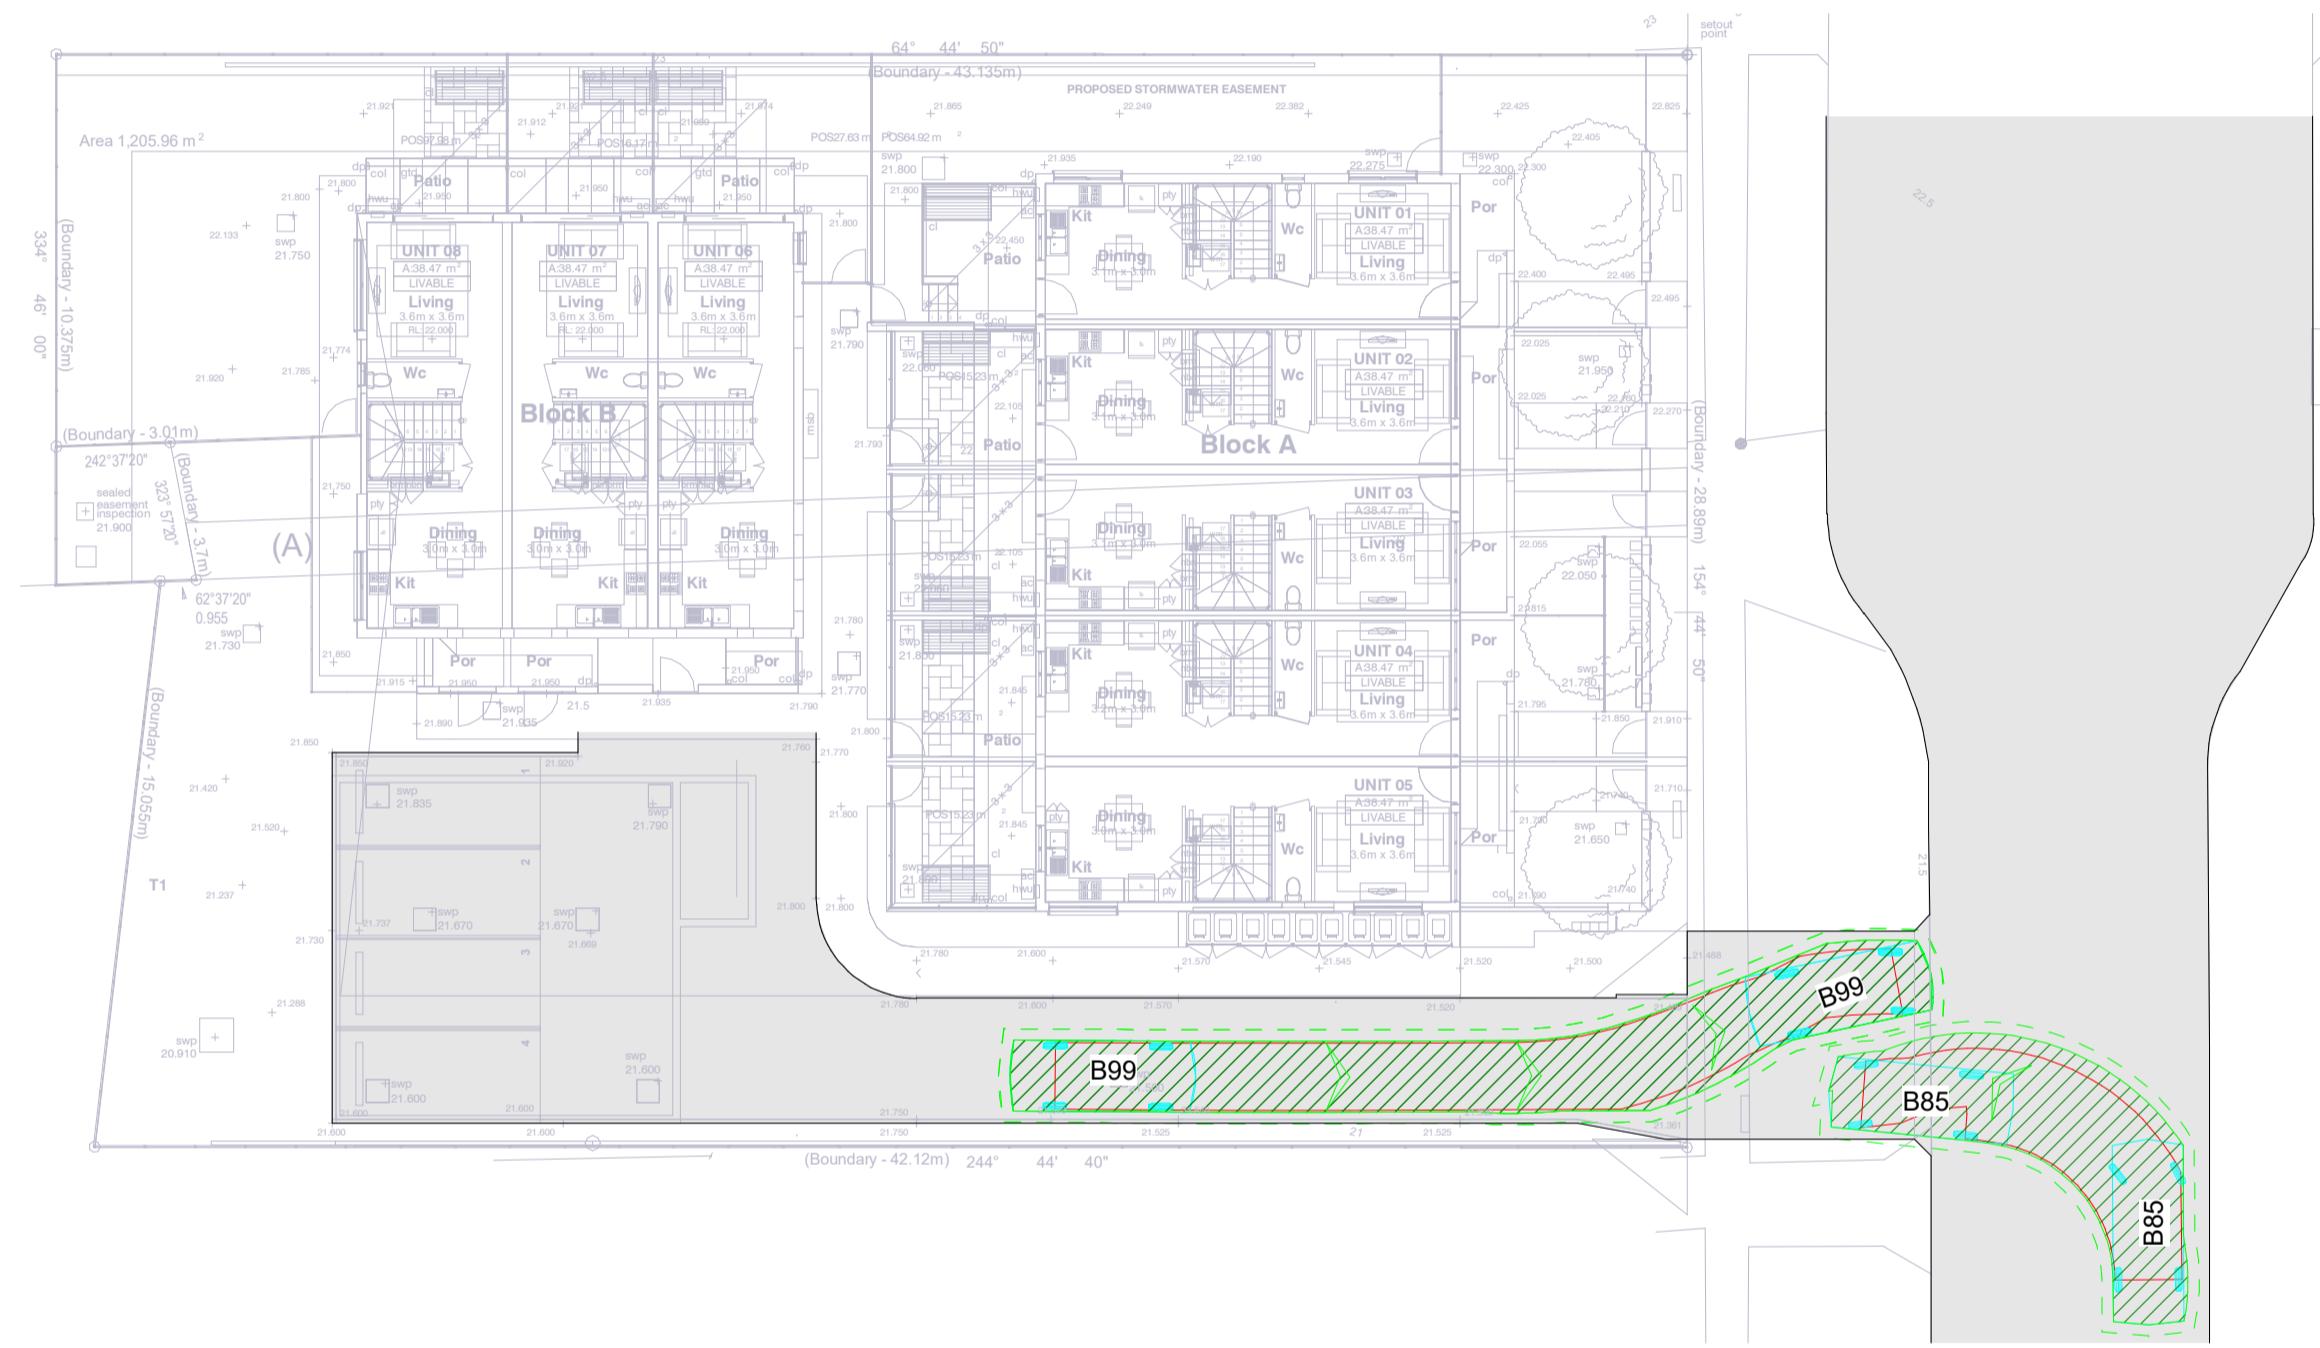

GROUND FLOOR - B85 & B99 PASSING

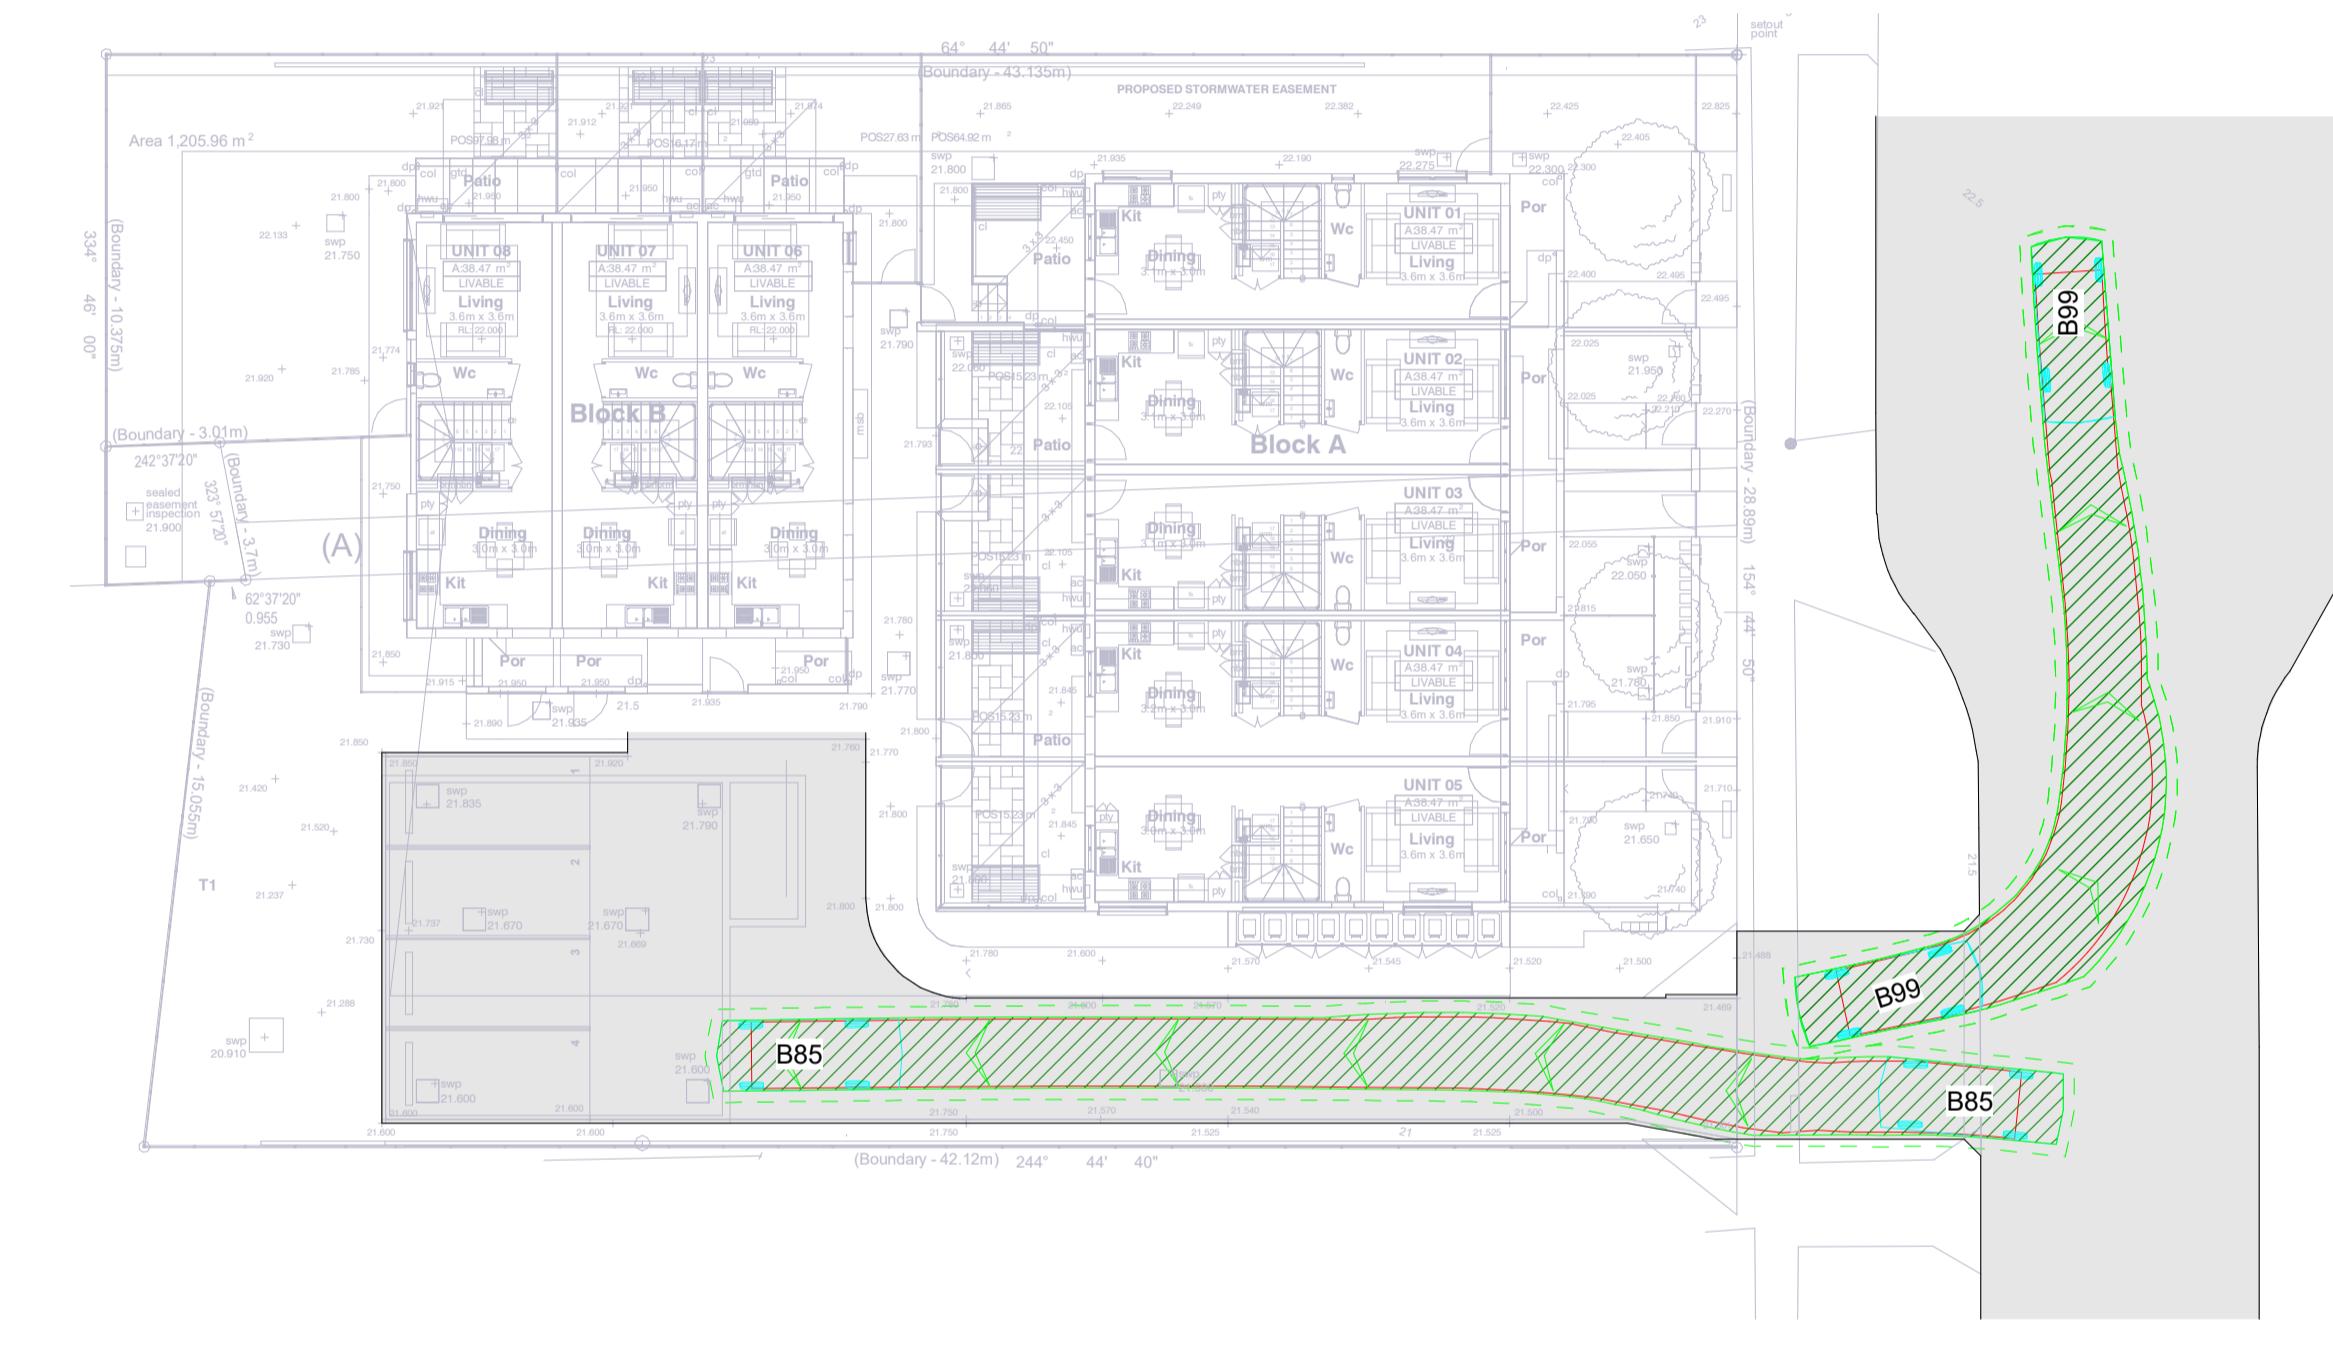

GROUND FLOOR - B85 & B99 PASSING




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	ARCHITECT
	STANTON DAHL ARCHITECTS
	PROJECT MANAGER
	LAND & HOUSING CORPORATION
SCRIPTION	ELECTRICAL CONSULTANT
with Greenview	GREENVIEW CONSULTING

CTS	STRUCTURAL CONSULTANT GREENVIEW CONSULTING Pty Ltd
RATION	HYDRAULIC CONSULTANT GREENVIEW CONSULTING Pty Ltd
Pty Ltd	LANDSCAPE CONSULTANT RFA LANDSCAPE ARCHITECTS



Family & Community Services

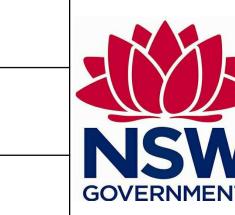Land & Housing Corporation

GREATER WESTERN SYDNEY REGION

PROJECT:


**PROPOSED
DEVELOPMENT**

AT

71-73 Vicliffe Avenue, Campsie, NSW

TITLE:
**GROUND FLOOR TURNING
PATHS SHEET 2**

DA			
DATE: 23.11.2022	SCALE: 200	PRJ:	JOB: 220215
STAGE: DA	DRAWN: JPS	DESIGN: JW	CHECKED: JW
TYPE: C	SHEET: C11	REV: 2	

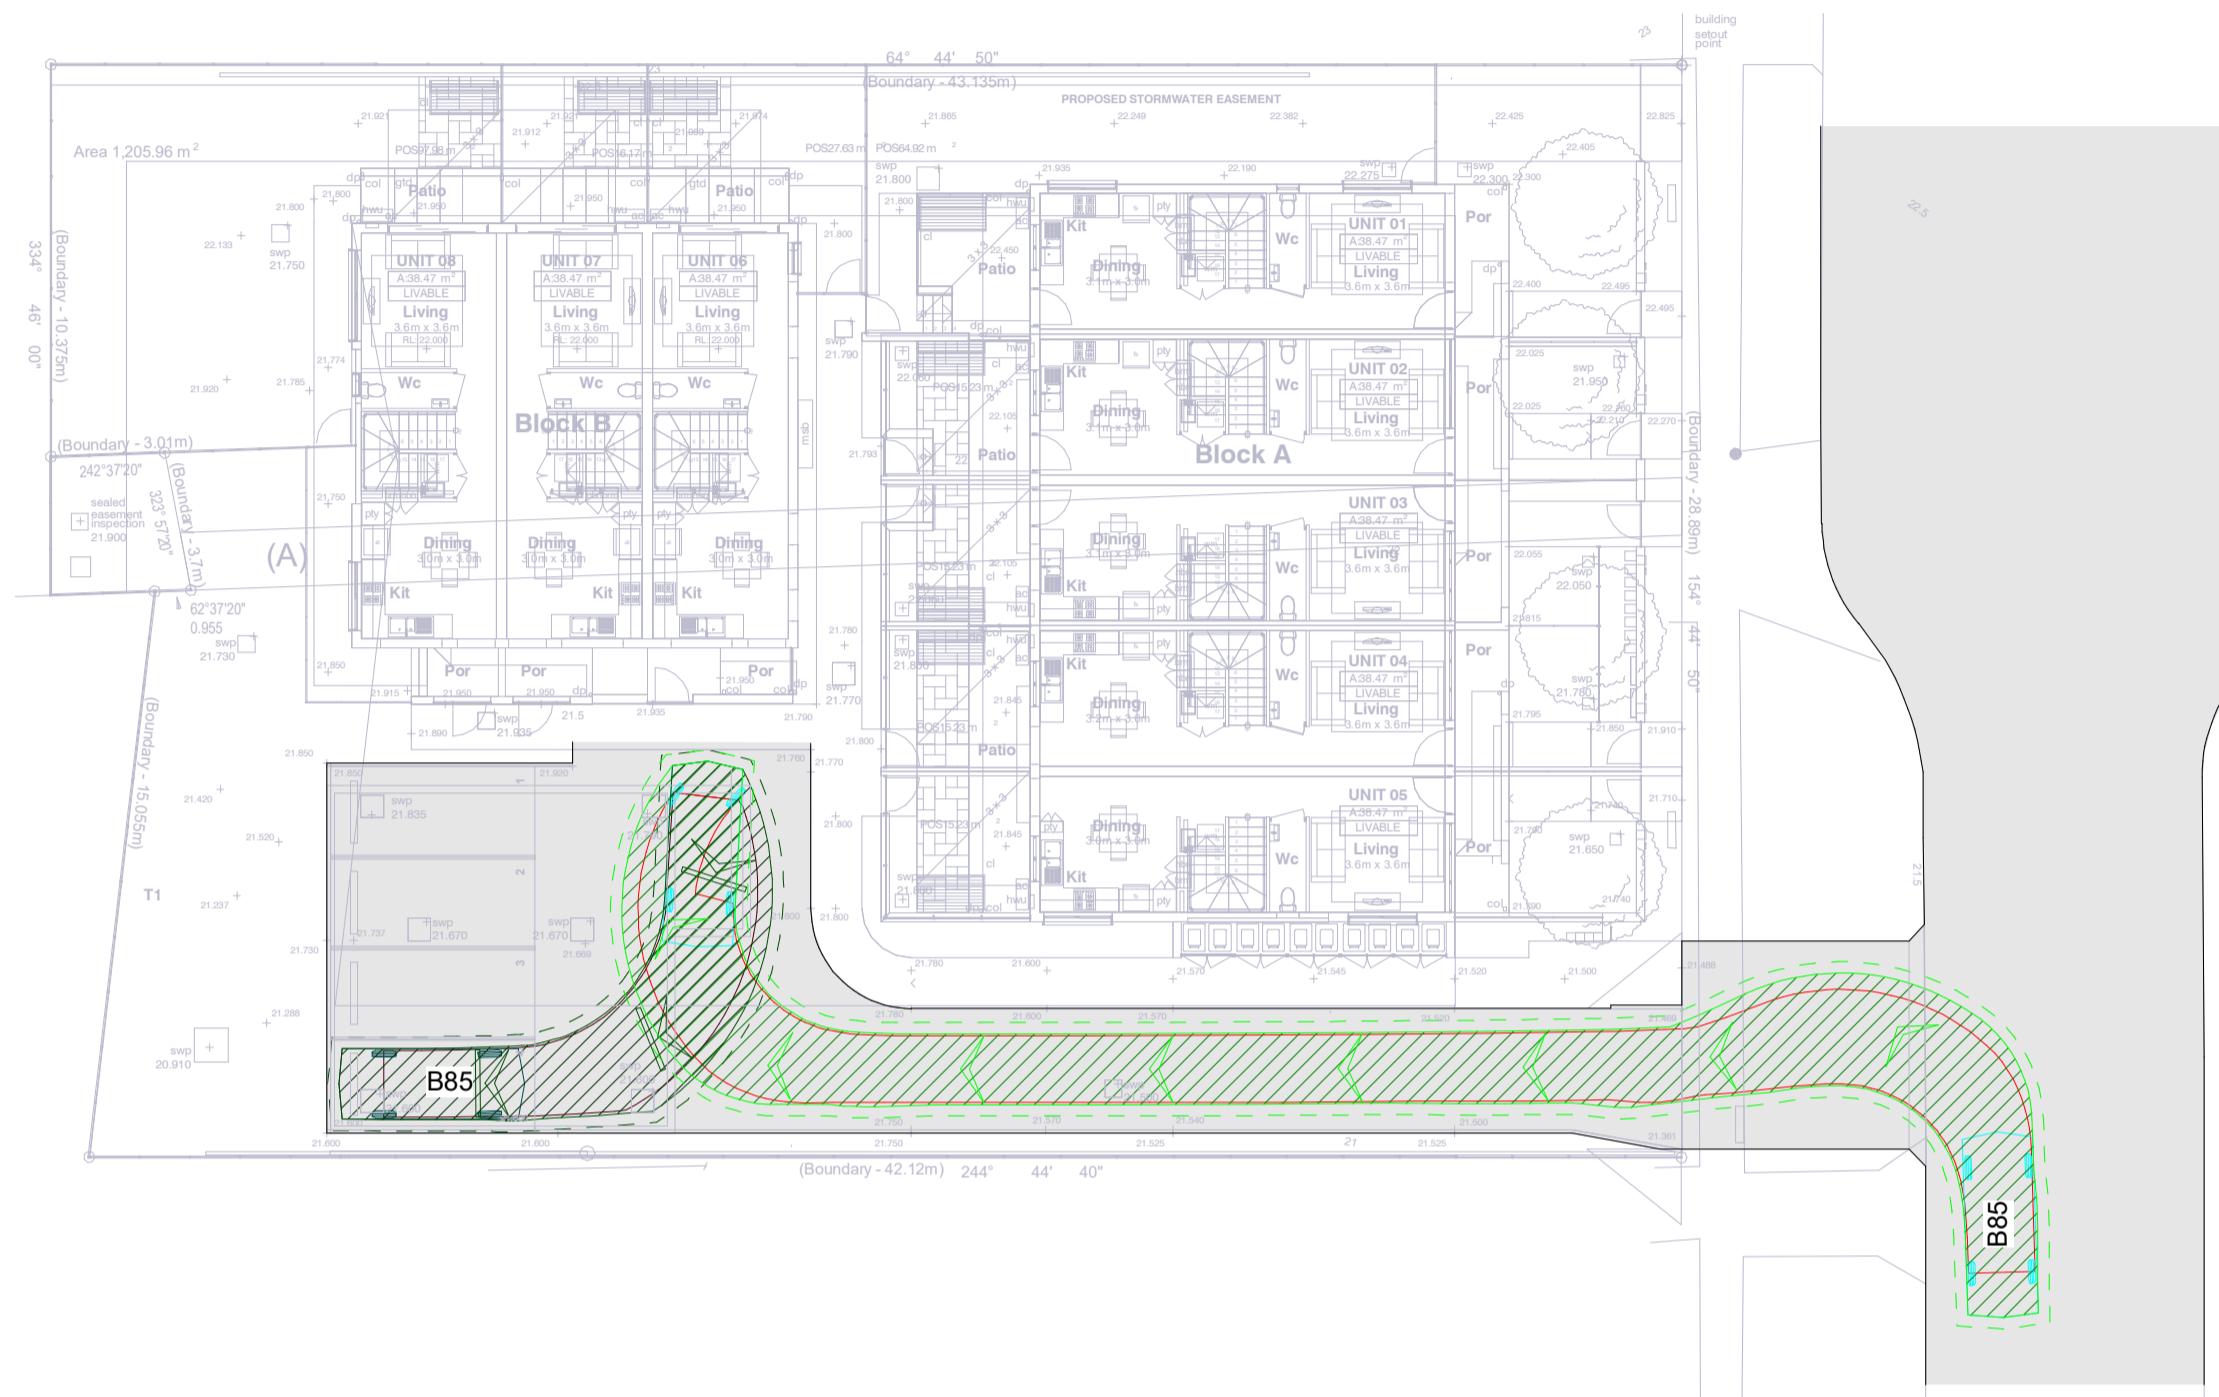

GROUND FLOOR - B85 ENTRY 1
Scale: 1:200



GROUND FLOOR - B85 EXIT 1
Scale: 1:200



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STANTON DAHL ARCHITECTS

PROJECT MANAGER
LAND & HOUSING CORPORATION

REV. DATE

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STRUCTURAL CONSULTANT
GREENVIEW CONSULTING Pty Ltd

HYDRAULIC CONSULTANT
GREENVIEW CONSULTING Pty Ltd

ELECTRICAL CONSULTANT
GREENVIEW CONSULTING Pty Ltd

LANDSCAPE CONSULTANT
RFA LANDSCAPE ARCHITECTS


BUSINESS PARTNER
NSW GOVERNMENT

Family & Community Services
Land & Housing Corporation
GREATER WESTERN SYDNEY REGION

PROJECT:
PROPOSED DEVELOPMENT
AT
71-73 Vicliffe Avenue, Campsie, NSW


TITLE:
GROUND FLOOR TURNING PATHS SHEET 3

STATUS: DA
DATE: 23.11.2022: 200 PRU: 220215
SCALE: 1:200
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DA JPS JW JW
TYPE: SHEET: REV:
C C12 2

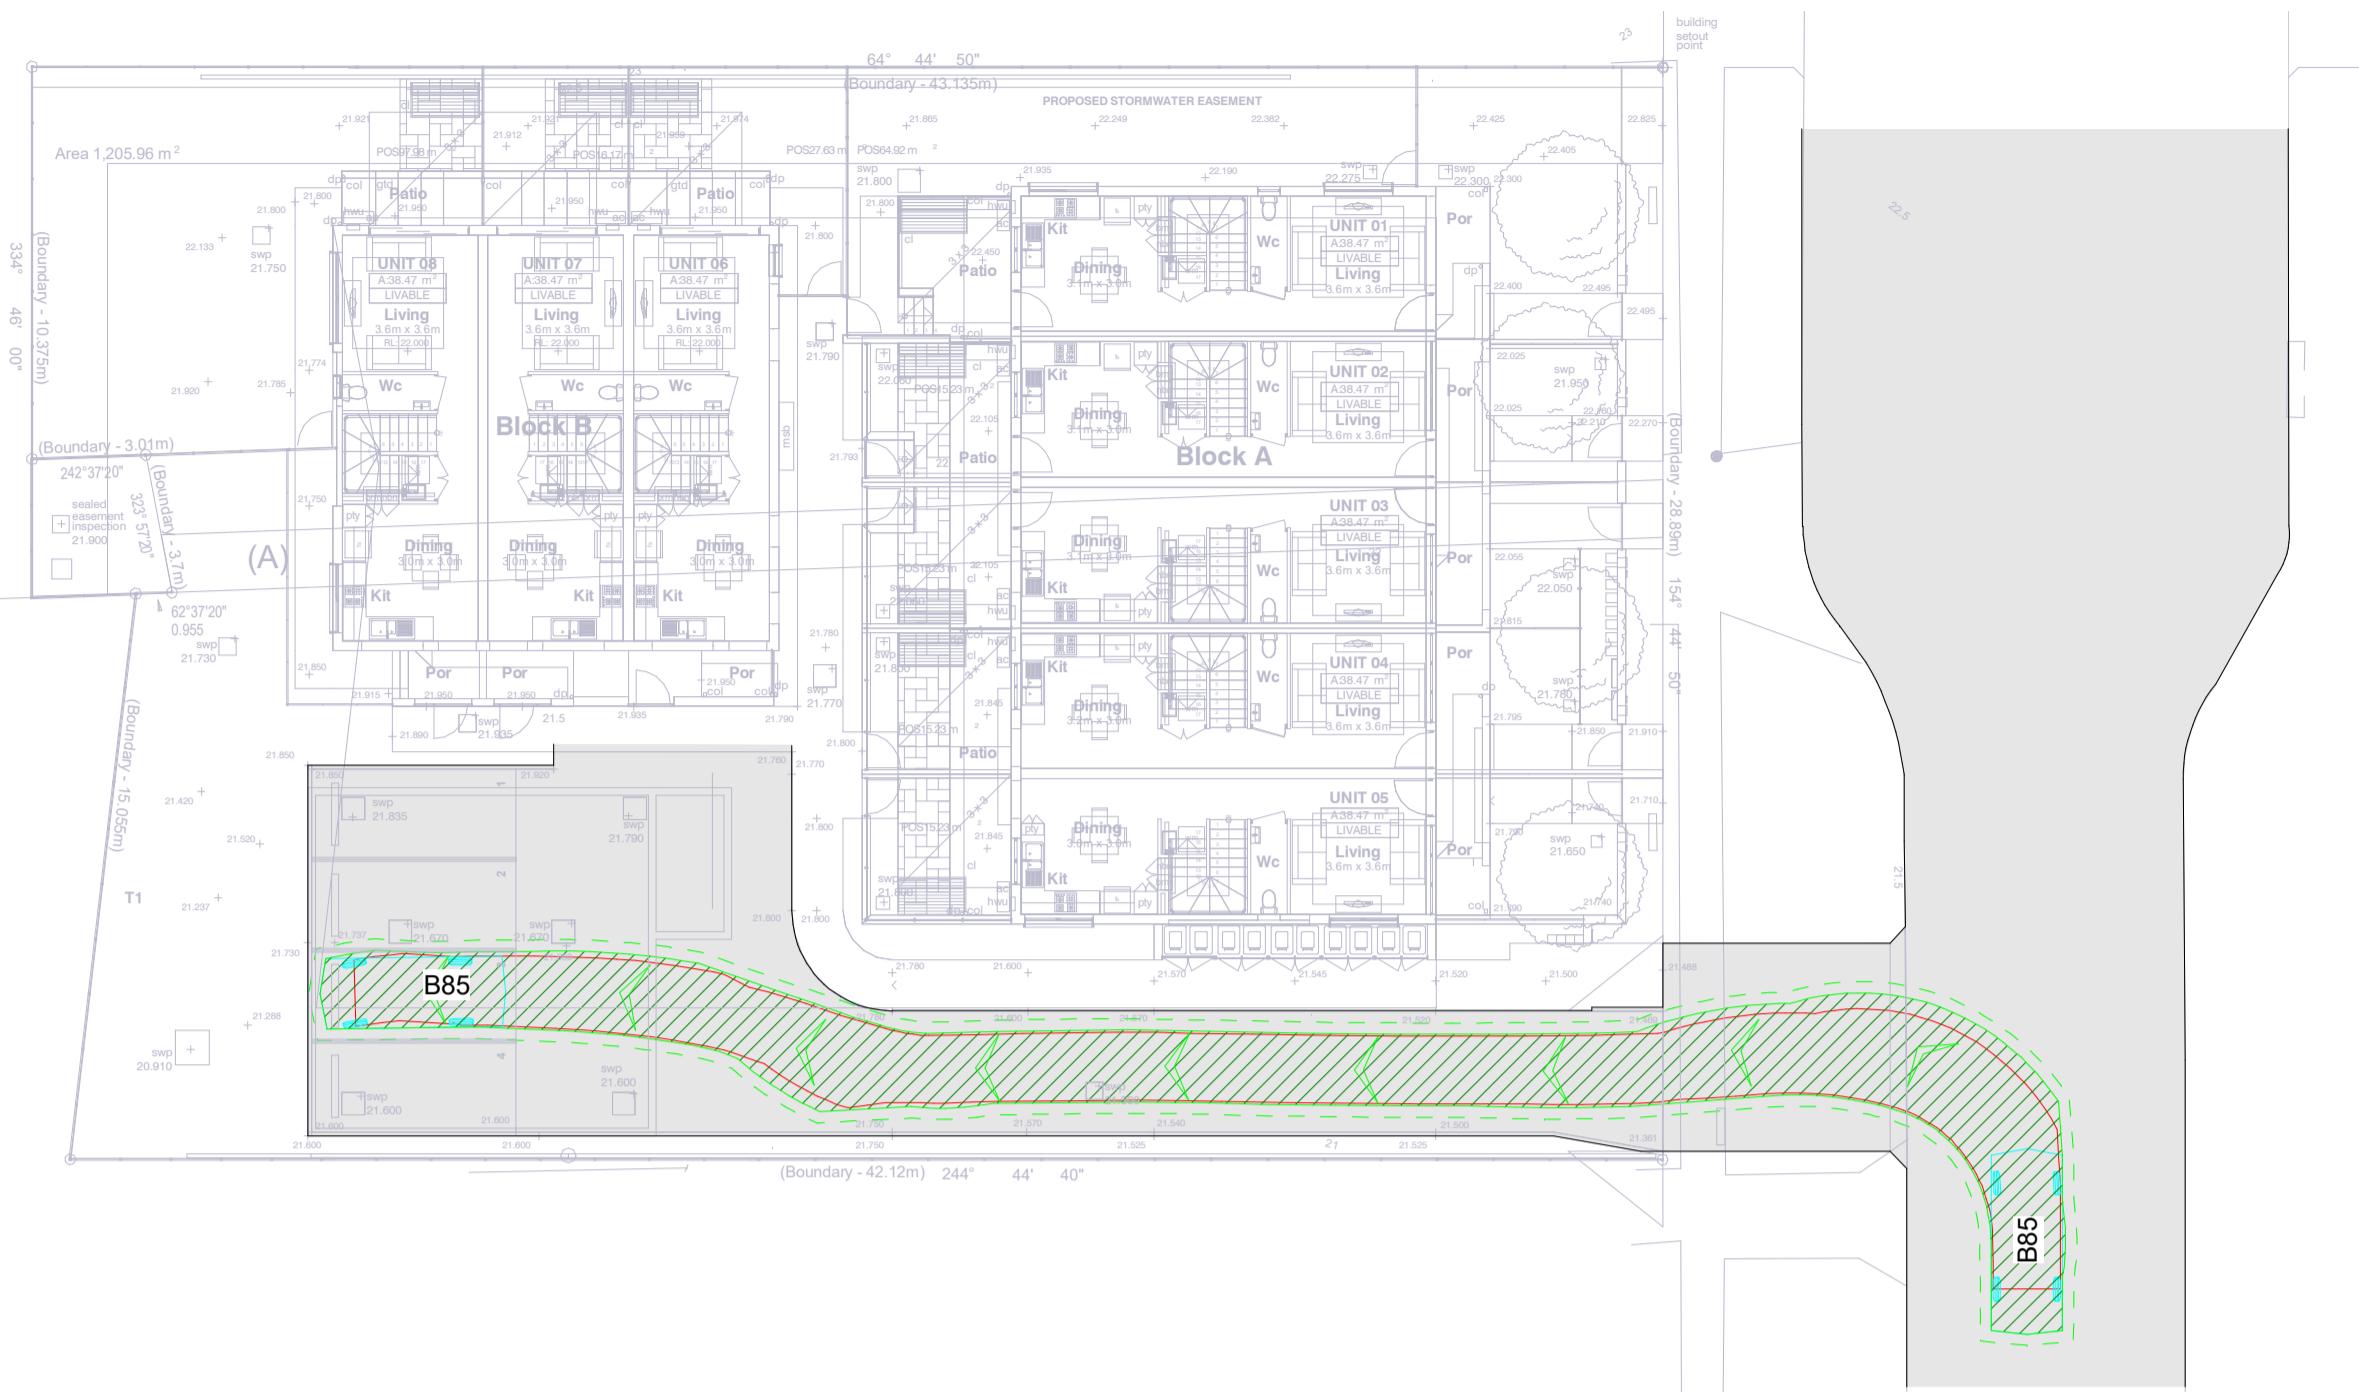


GROUND FLOOR - B85 ENTRY 2

Scale: 1:200

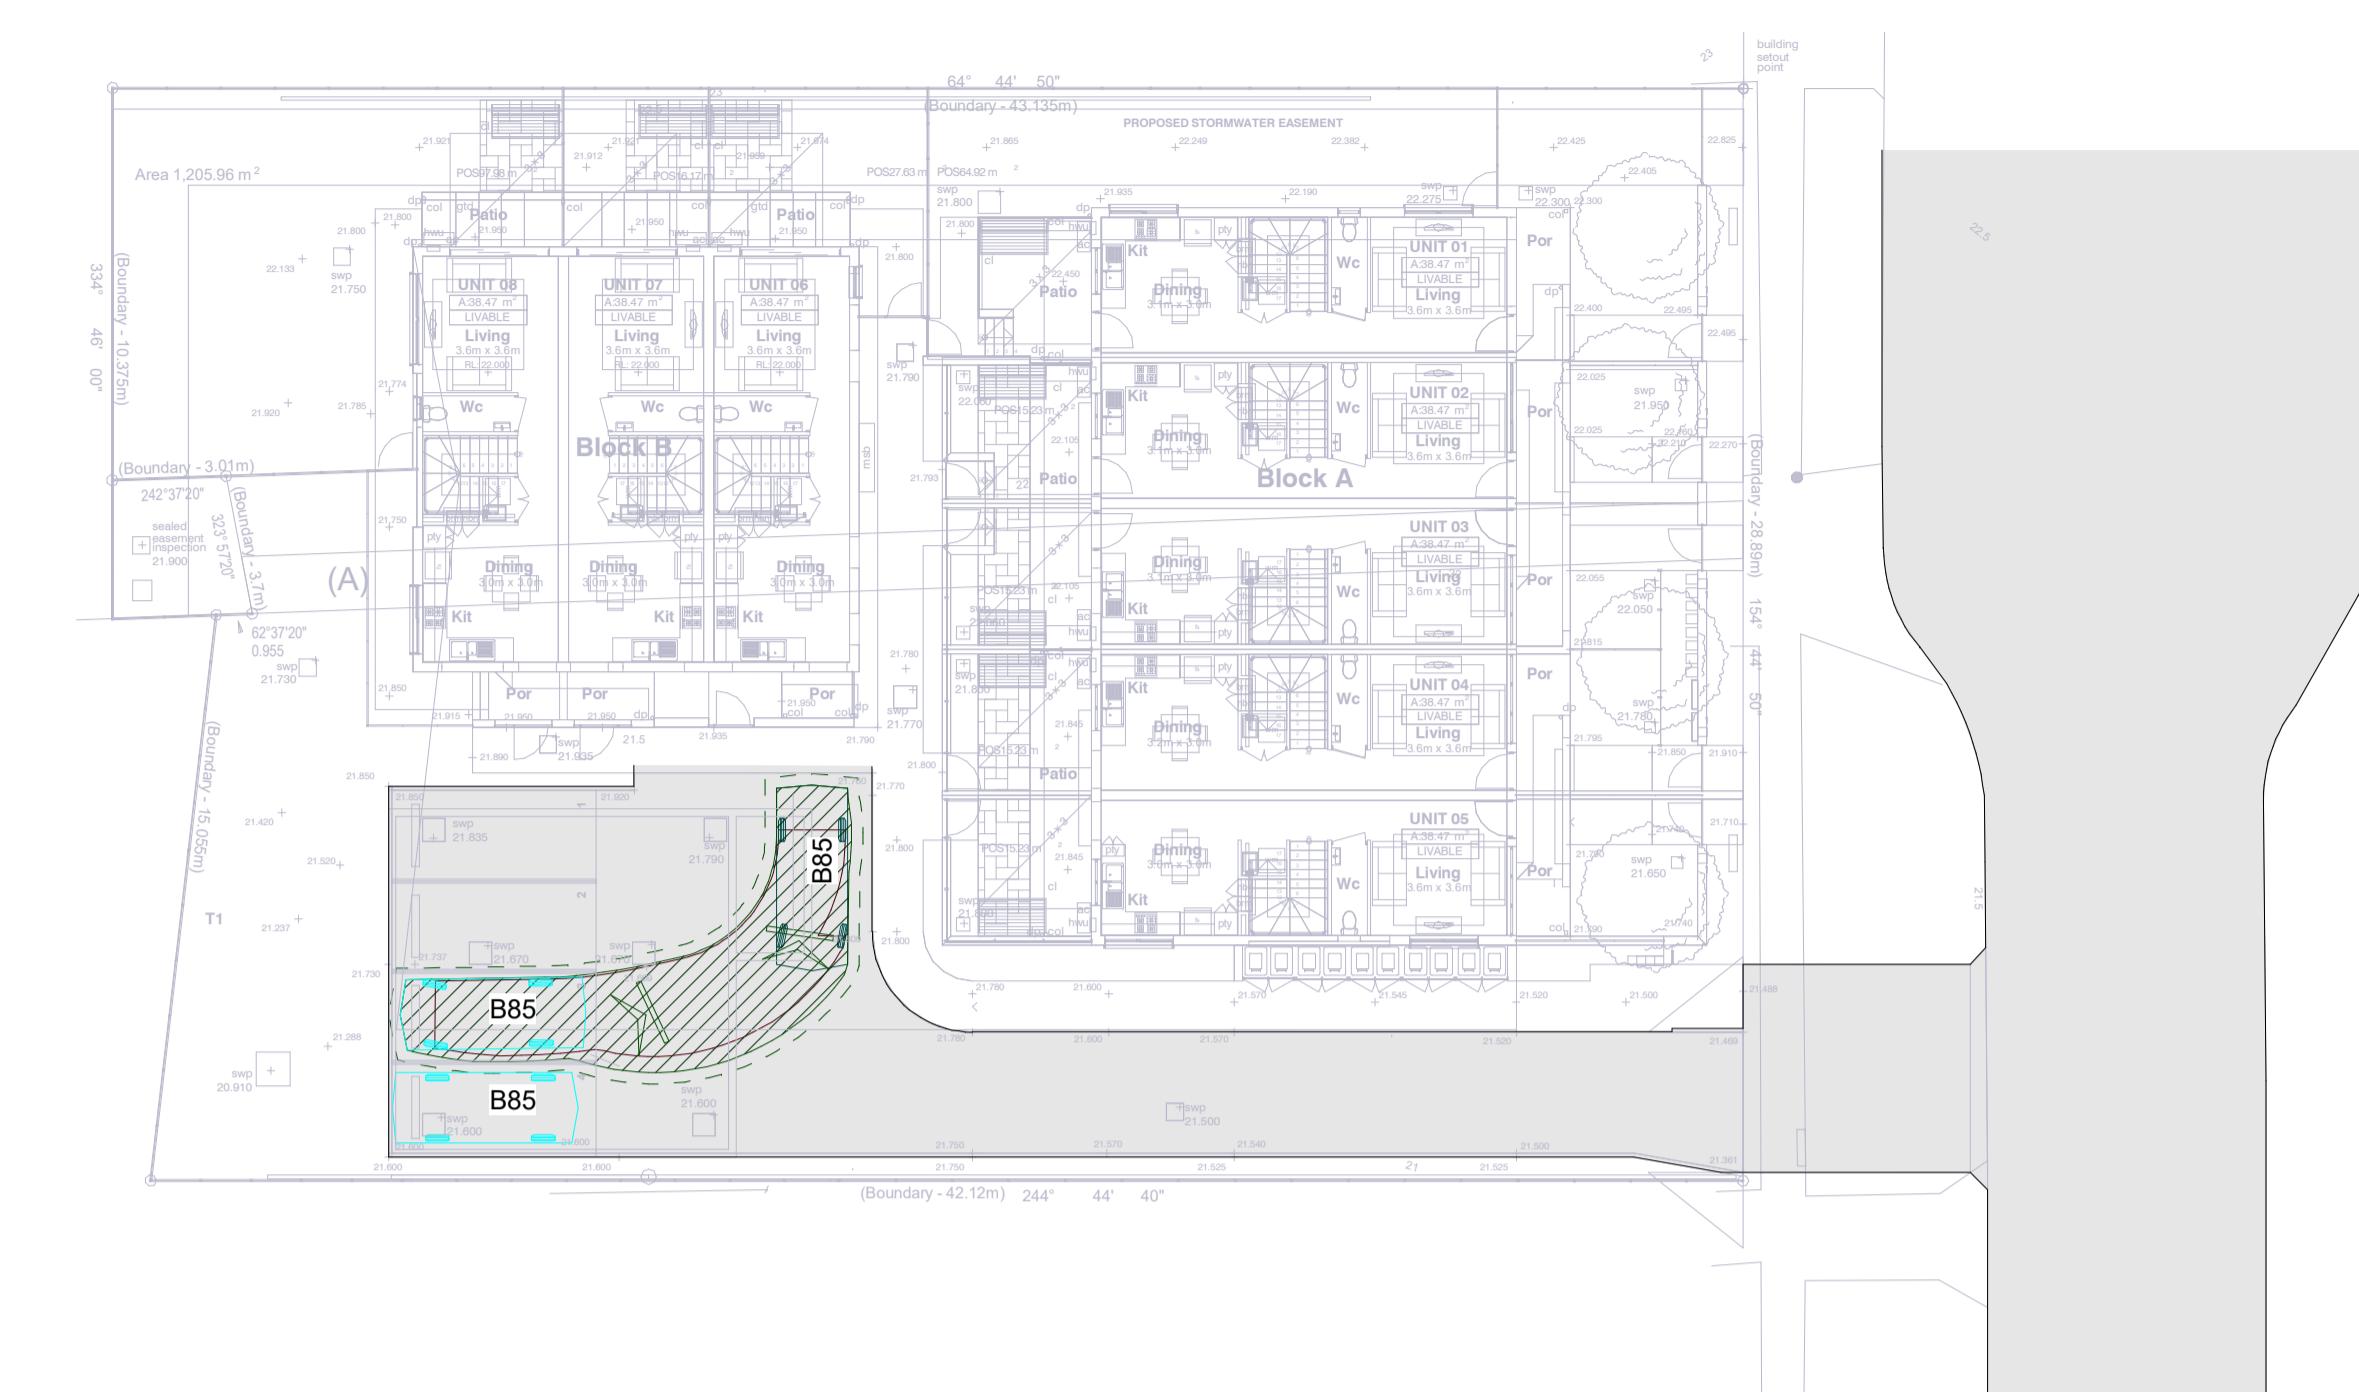

GROUND FLOOR - B85 EXIT 2a

Scale: 1:200

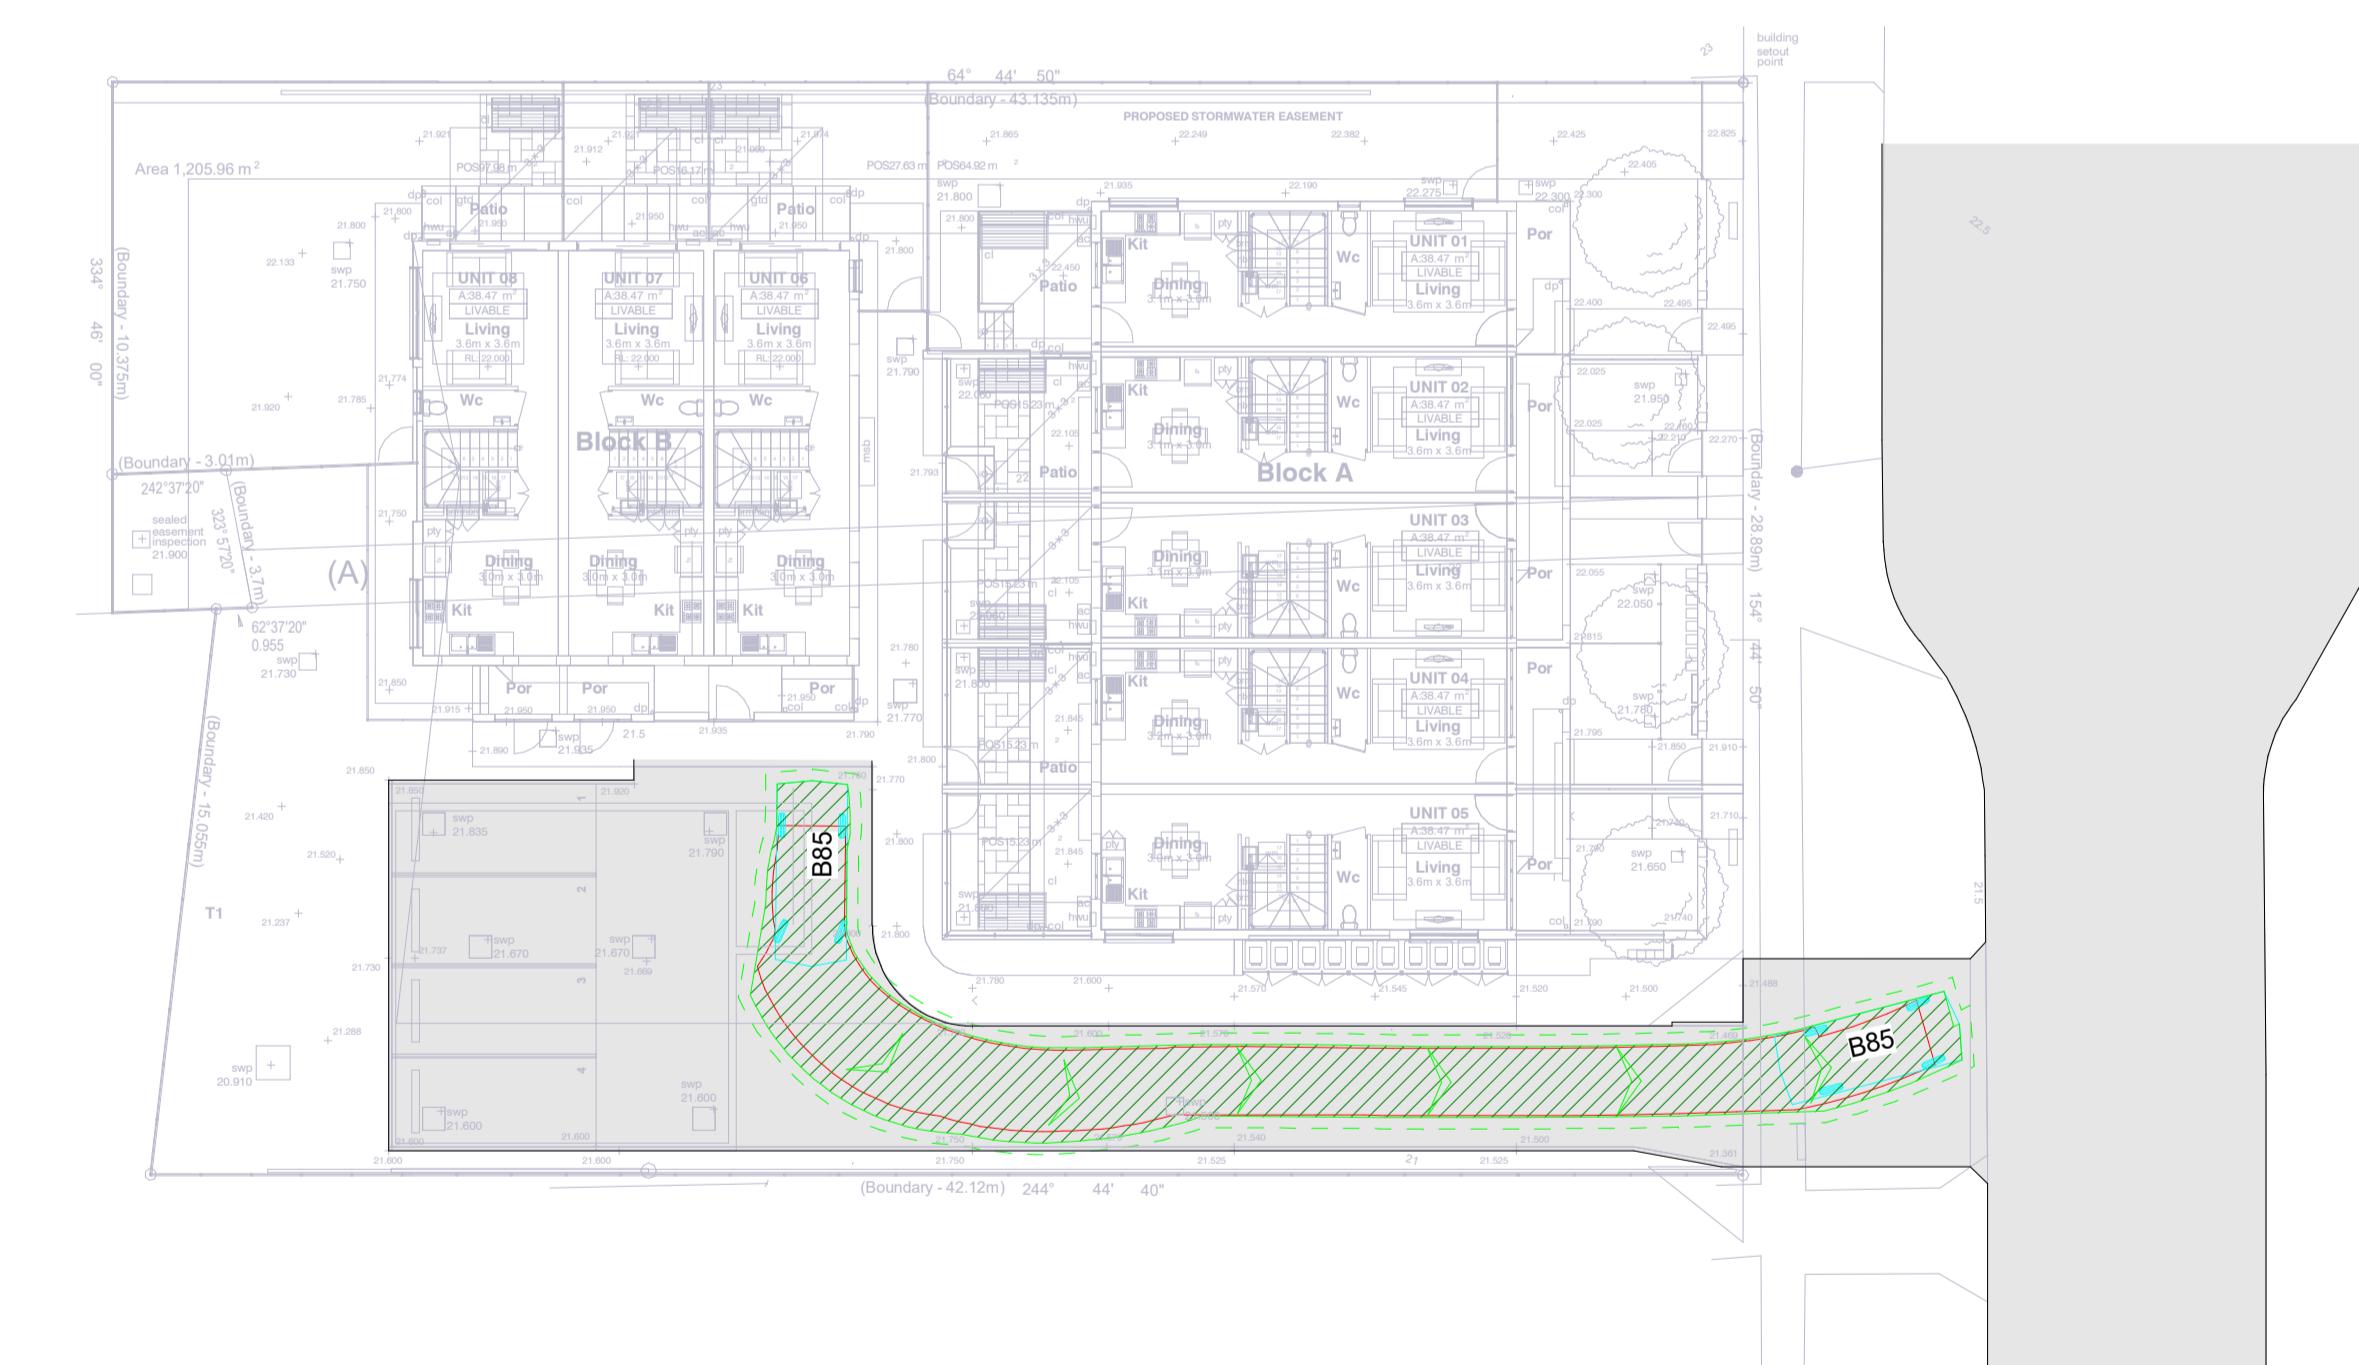

GROUND FLOOR - B85 EXIT 2b

Scale: 1:200



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PROJECT MANAGER	HYDRAULIC CONSULTANT
LAND & HOUSING CORPORATION	GREENVIEW CONSULTING Pty Ltd

ELECTRICAL CONSULTANT	LANDSCAPE CONSULTANT
GREENVIEW CONSULTING Pty Ltd	RFA LANDSCAPE ARCHITECTS

Family & Community Services
NSW GOVERNMENT
Land & Housing Corporation
GREATER WESTERN SYDNEY REGION

PROJECT:
PROPOSED DEVELOPMENT
AT
71-73 Vicliffe Avenue, Campsie, NSW

TITLE:
GROUND FLOOR TURNING PATHS SHEET 4

STATUS:
DA

DATE: 23.11.2022: 200	SCALE: 1:200	PRJ: JPS	JOB: 220215
STAGE: DA	DRAWN: JPS	DESIGN: JW	CHECKED: JW
TYPE: C	SHEET: C13	REV: 2	



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w: www.greenview.net.au
Greenview Consulting Pty Ltd
A.B.N 32 600 067 338

VEHICULAR ACCESS DESIGN STATEMENT

PROJECT: Proposed Residential Development

DATE: 16th November 2022

CLIENT: Simpson Building Group

REFERENCE: 220215

ADDRESS: 71-73 Vicliffe Ave, Campsie NSW 2194

REVIEW DRAWINGS: Stanton Dahl Architects, Job No. 2789.22, Drawing No. DA04

ELEMENTS:

- Driveway Grades
- Carparking Compliance
- Parking Manoeuvrability

We hereby confirm that we have reviewed the above design elements and found them to be in accordance with the relevant Australian standards and relevant conditions of the development consent. In particular, the design is in accordance with the following:

REFERENCE	TITLE
AS2890.1:2004	Parking facilities - Off-street Parking
AS/NZS 2890.6:2009	Parking facilities - Off-street parking for people with disabilities

We note that the driveway grades and the ingress/egress from the car spaces are compliant.

Note: this report is specifically related to the items referred to and is not to be construed to represent a comment on any other areas of the property.

Yours faithfully,

For & on behalf of Greenview Consulting,

Prepared by:

A handwritten signature in black ink, appearing to read "Anthony Oste".

Anthony Oste

Traffic Designer

Reviewed by:

A handwritten signature in blue ink, appearing to read "Alistair McKerron".

Alistair McKerron B.E., M.I.E.(Aust.), CP Eng., NPER no 2220277

Project Engineer

UNIT 01

21
DP35130

47
DP11479

48
DP11479


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DP35848

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DP35848

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DP35848

1 Site Plan
1:100

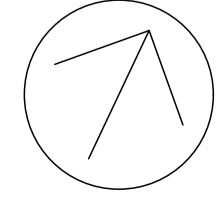

01 | 13/11/22 | Part 5 Issue
Rev Date Issue
do not scale drawings. check all dimensions on site.
figured dimensions take precedence.

Project Architect:
Stanton Dahl Architects
Ph: (02) 8876 5300
Landscape Consultant:


Hydraulic & Structural Consultant:
Architect:

Electrical Consultant:


Stanton
Dahl
Architects

Project:
Multi Dwelling Housing Development (8x2
Bed Townhouses)
at
71-73 Vicliffe Avenue, Campsie

Title:
Site & External Works Plan
File:
2789.22_Site Master_71-73
Vicliffe Ave, Campsie.pln
Status: Part 5 Activity - ADD DATE
Date: 14/11/22 Scale: 1:100 @ A1 S/d job no. 2789.22
Stage: Drawn: BGVRM Checked: JOK Approved:
DD: Sheet: JOK Rev:

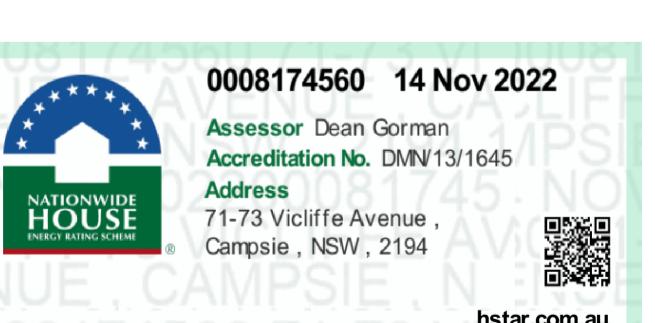

Legend (external work / site plan)
 ex. contours & banking line
 existing trees to be retained
 proposed new trees
 existing stormwater easement
 proposed stormwater easement
 existing ground levels
 proposed levels
 RL00.00 → proposed levels
 + 39.000 proposed spot levels (ftl)
 ac accessible
 acc ageing, disability & home care
 adhc access panel
 ap balustrade (type)
 bfc broom finished concrete
 boe brick on edge
 bol bollard
 cc(1) coloured concrete (type)
 cft(1) ceramic tile (type)
 cl clothes line
 col column
 dp downpipe
 drp doopstop
 ex. existing
 fb(1) facebrick work (type)
 ffl finished floor level
 ft(1) fence (type)
 gb garbage bin
 gt gate
 grated drain
 handrail (type)
 ht hose tap
 hru hot water unit
 hydrant
 kr kerb ramp
 lb letter box
 ofc off concrete
 pavers (type)
 pos private open space
 pmp permeable paving
 pp power pole
 rw(1) retaining wall (type)
 rwo rainwater outlet
 rwt rainwater tank
 sfc structural floor level
 stl storm water pit
 tlc trowel finished concrete
 tgci tactile ground surface indicator
 tow top of wall
 wfc wood float concrete
 ws wheel stop

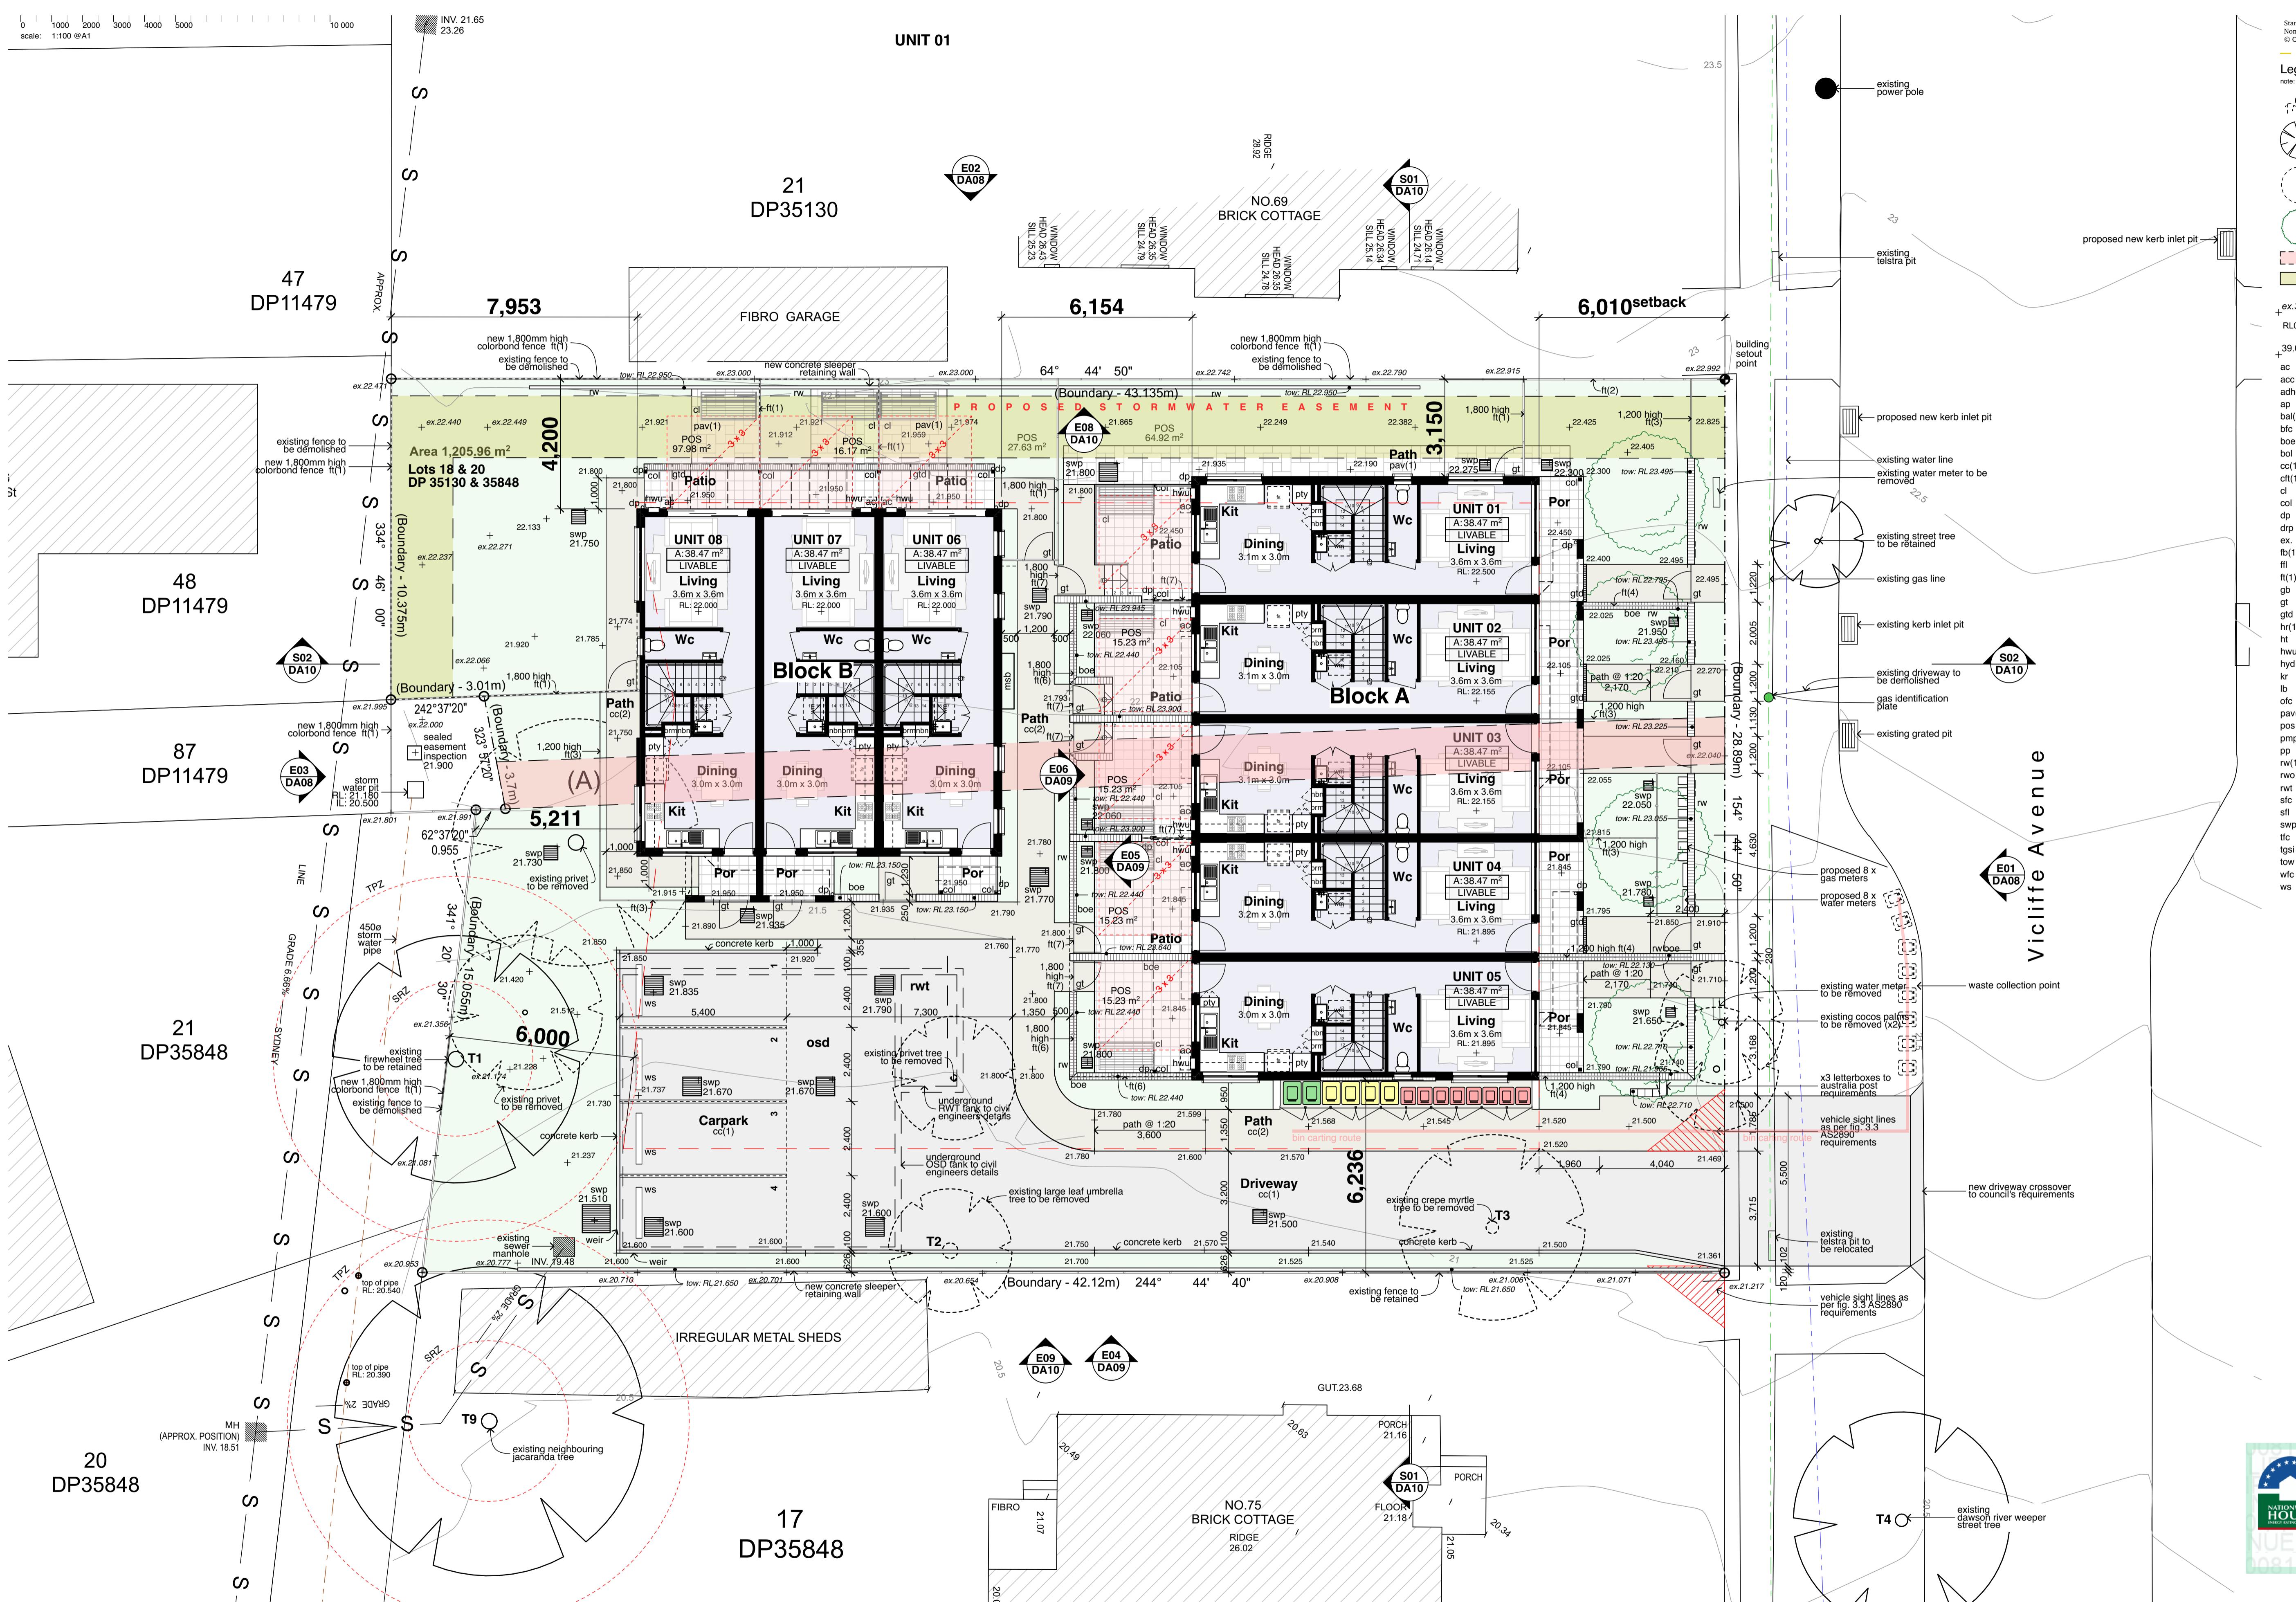



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Stanton Dahl Architects

Date
20th January 2023

Job Number
220215

**Traffic for proposed multi-dwelling housing development
71-73 Vicliffe Ave, Campsie NSW**

Dear Sir/Madam,

Please find following our response to Council's issues raised in their 20th December 2022 email "FW: Council comments on Multi Unit Housing - 71-73 Vicliffe Ave Campsie - NB-2-2022 - SUB22-225676", point 4e) "Areas to address with the bin storage area".

4e) Areas to address with the bin storage area: Architect to review and advise. Noted.

5. *The area must be no more than 10m from kerbside collection point, where the vehicle will park;*
6. *Bin-carting route cannot be via the driveway or carpark; and*

Greenview confirms that the "bin carting route", as identified on Stanton Dahl Architects design drawing DA04, will have no notable impact on the functionality of the internal driveway or the crossing within council's road reserve. Although the "bin carting route" is approximately 13m from the kerbside collection point, it occurs only along the pedestrian pathway within the site, and due to the very low frequency of vehicles entering the site, the movement of the bins across the waiting bay will have no notable impact on any vehicle traffic flow, and thus Greenview deems this arrangement as acceptable.

Please do not hesitate to contact us if you require clarification or further information on any of the above issues.

Yours faithfully,

For & on behalf of Greenview Consulting,

Prepared by:

A handwritten signature in black ink, appearing to read "Anthony Oste".

Anthony Oste

Traffic Designer

Reviewed by:

A handwritten signature in blue ink, appearing to read "Alistair McKerron".

Alistair McKerron B.E., M.I.E.(Aust.), CP Eng., NPER no 2220277

Senior Project Engineer

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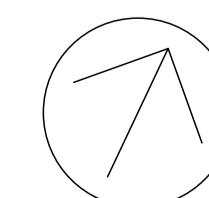
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DP35848

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DP35848

1 Site Plan
1:100



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02	18/01/23	Revised Part 5 Issue
01	18/11/22	Part 5 Issue
do not scale drawings. check all dimensions on site. figured dimensions take precedence.		
Rev	Date	Issue

Project Architect:
Stanton Dahl Architects
Ph: (02) 8876 5300

Landscape Consultant:

Hydraulic & Structural Consultant:
Architect:

Electrical Consultant:

Stanton
Dahl
Architects

Project:
Multi Dwelling Housing Development (8x2
Bed Townhouses)
at
71-73 Vicliffe Avenue, Campsie

Title:
Site & External Works Plan
File:
2789.22_Site Master_71-73
Vicliffe Ave, Campsie.pln
Printed:
17/1/23
Drawing:
DA04
Sheet:
5 of 16

Legend (external work / site plan)
note: drawing may not contain all items listed below

- 64° ex. contours & banking line
- existing trees to be retained
- proposed new trees
- existing stormwater easement
- proposed stormwater easement
- proposed storm water pipe
- water services
- gas services
- + ex.39.000 existing ground levels
- RL0.00 → proposed levels
- +39.000 proposed spot levels (ft)
- ac air conditioner condenser
- acc accessible
- adhc ageing, disability & home care
- ap access panel
- bal(1) balustrade (type)
- bfc borm finished concrete
- boe brick on edge
- bol bollard
- cc(1) coloured concrete (type)
- cft(1) ceramic floor tile (type)
- cl clothes line
- col column
- dp downpipe
- drp doorpost
- ex. existing
- fb(1) facebrick work (type)
- fi(1) finished floor level
- fence (type)
- gb garbage bin
- gt gate
- grated drain
- hr(1) handrail (type)
- ht hose tap
- hwu hot water unit
- hydr hydrant
- kr kerb ramp
- lb letter box
- ofc off form concrete
- pav(1) pavers (type)
- pos private open space
- pmp permeable paving
- pp power pole
- rw(1) retaining wall (type)
- rwo rainwater outlet
- rwrt rainwater tank
- sfc steel float concrete
- sfl structural floor level
- swp storm water pit
- tfc trowel finished concrete
- tgsi tactile ground surface indicator
- tow top of wall
- wfc wood float concrete
- ws wheel stop